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11/10/2021 DEVELOPMENT APPLICATION DATE REVISION ISSUE




NORTH


ARCHITECTURE PROJECT PROPOSED RURAL CABINS INTERIORS LANDSCAPES ph - 02 6687 0535 CLIENT po box 1517

RALPH MAMONE ADDRESS 72, LAWLERS LANE - BANGALOW LOT 2 DP 1007622

DESIGN STAGE	DEVELOPMEN APPLICATION
TITLE	SITE PLAN 01

PROJECT	2004	DRAWING NO.	
DRAWN	GB	01	
CHECKED	JG	ISSUE	
SCALE	1:3000	1	

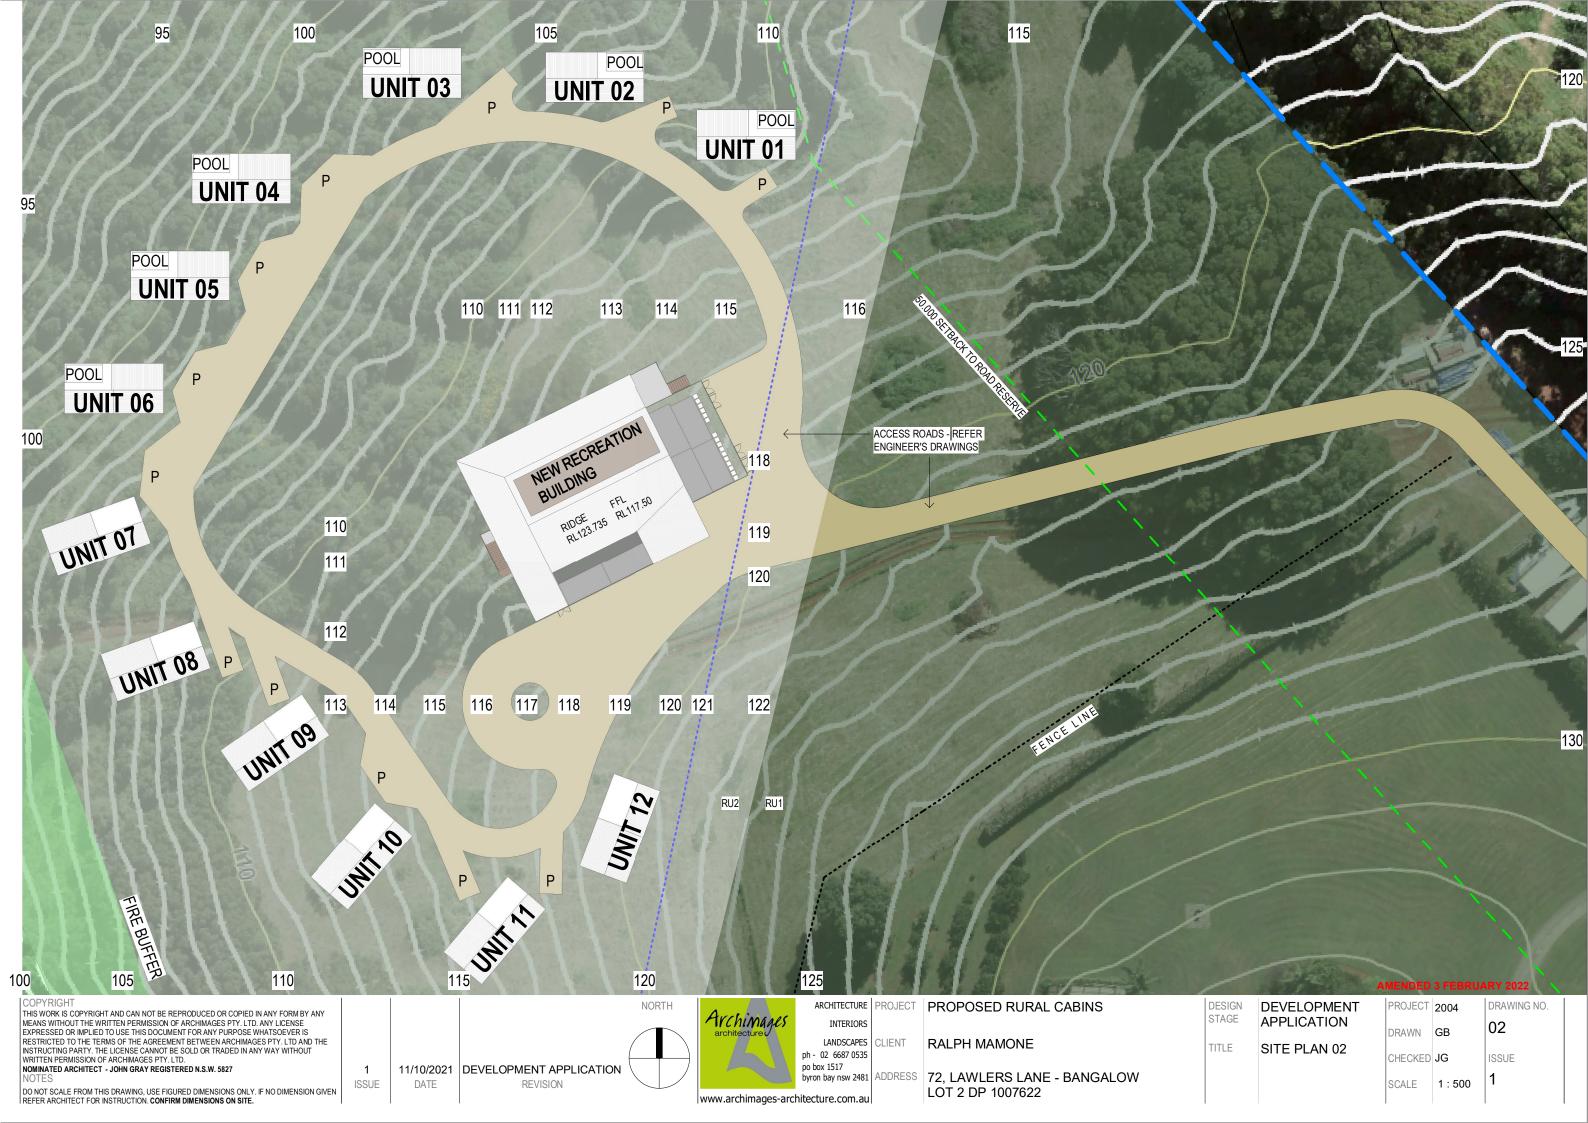

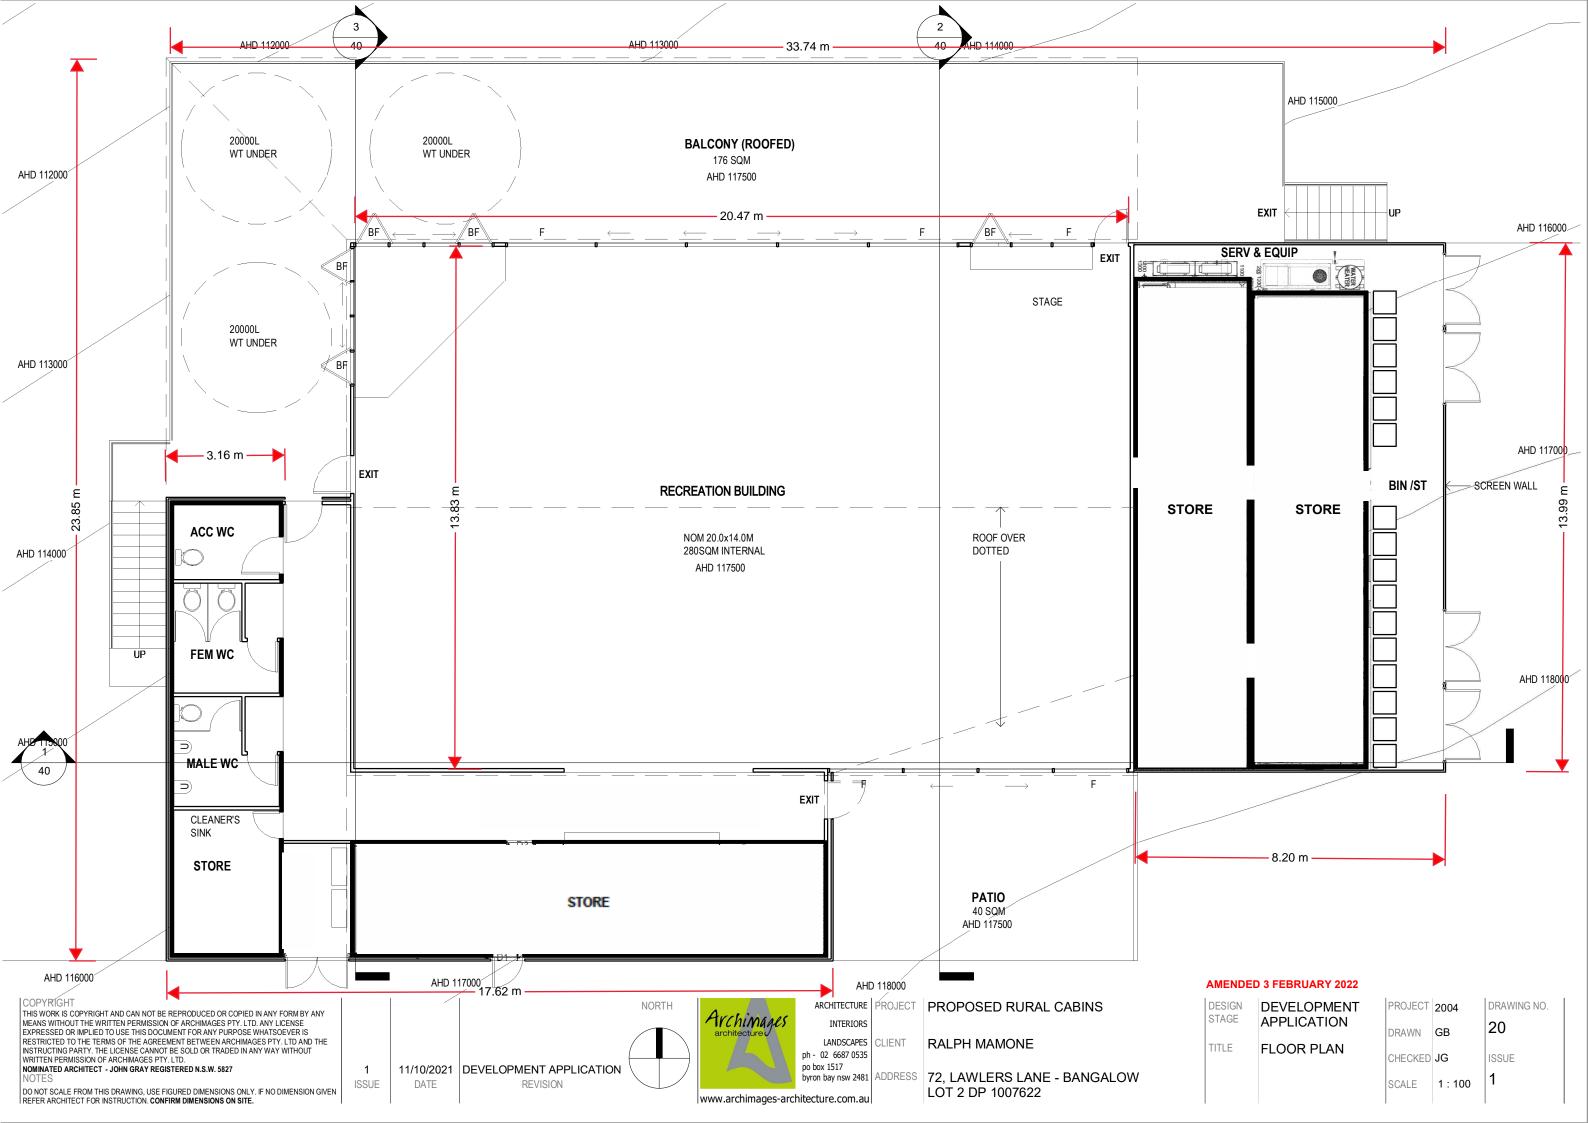





3x20,000L WATER TANKS UNDER NW CORNER OF BALCONY

SOLAR PHOTOVOLTAIC SYSTEM ON ROOF



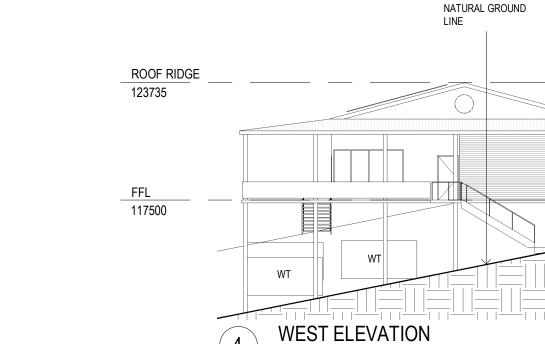

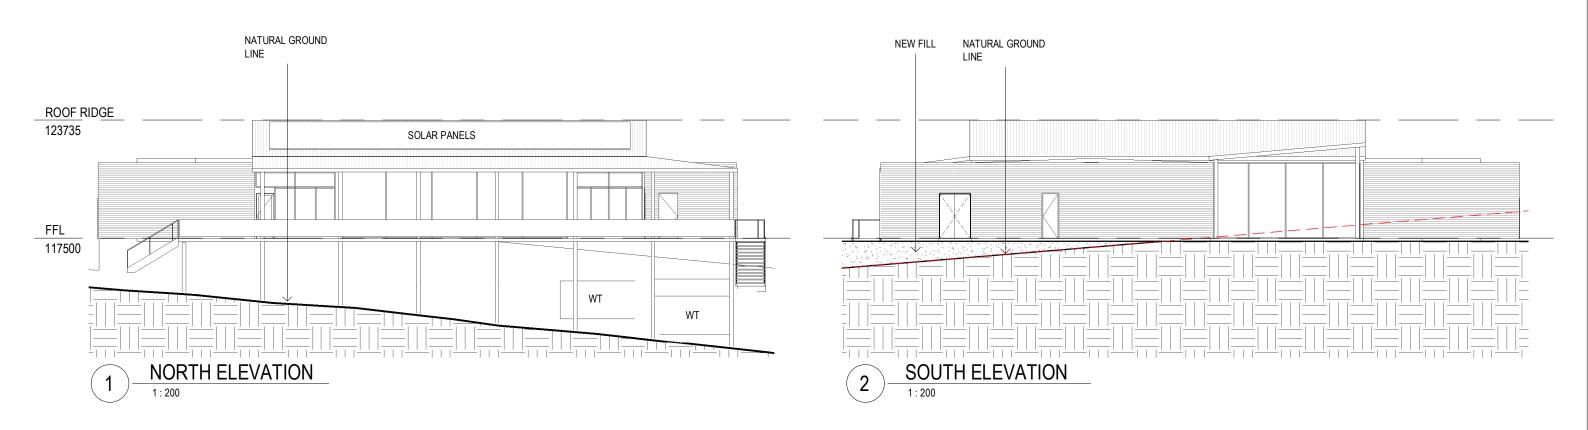

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NOTES

EAST ELEVATION

1:200

ROOF RIDGE

123735

FFL

117500

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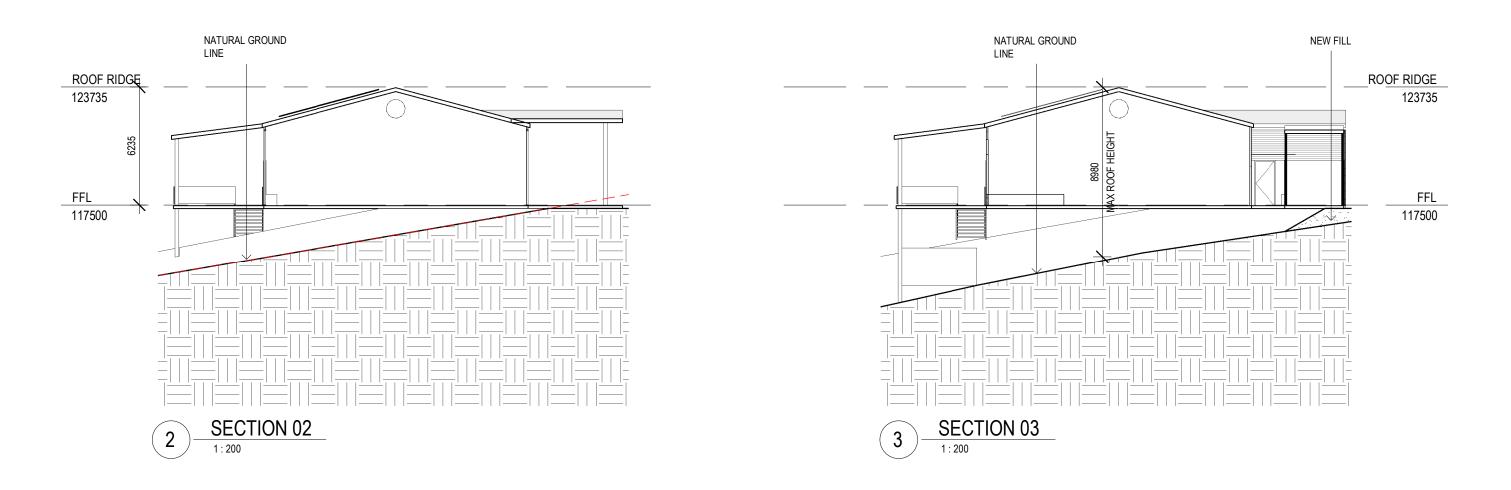
ARCHITECTURE	PROJECT	PROPOSED RURAL CABINS
INTERIORS		
LANDSCAPES n - 02 6687 0535		RALPH MAMONE
box 1517 Fron bay nsw 2481	ADDRESS	72, LAWLERS LANE - BANGALOW
octuro com au		LOT 2 DP 1007622


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DRAWING NO.

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ISSUE





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1 ISSUE	11/10/2021 DATE	DEVELOPMENT APPLICATION REVISION

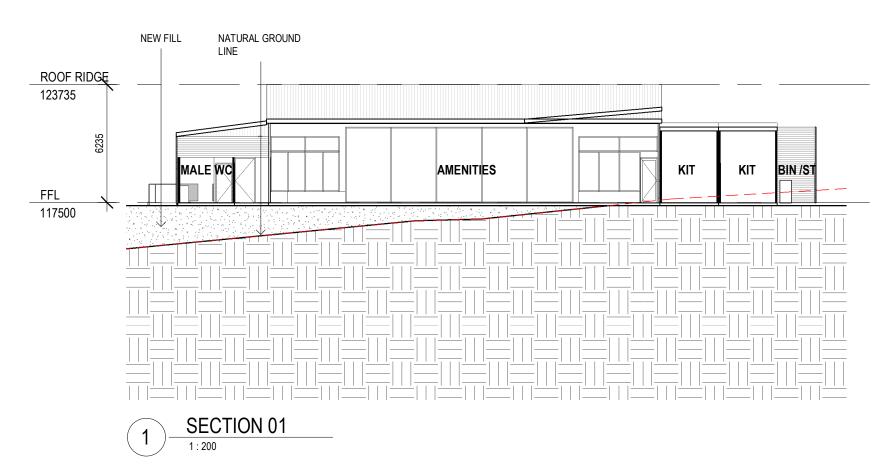
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INTERIORS		
ANDSCAPES 2 6687 0535		RALPH MAMONE
	ADDRESS	72, LAWLERS LANE LOT 2 DP 1007622
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Τ	PROPOSED RURAL CABINS
	RALPH MAMONE
S	72, LAWLERS LANE - BANGALOW

DESIGN STAGE	DEVELOPMENT APPLICATION
TITLE	SECTIONS

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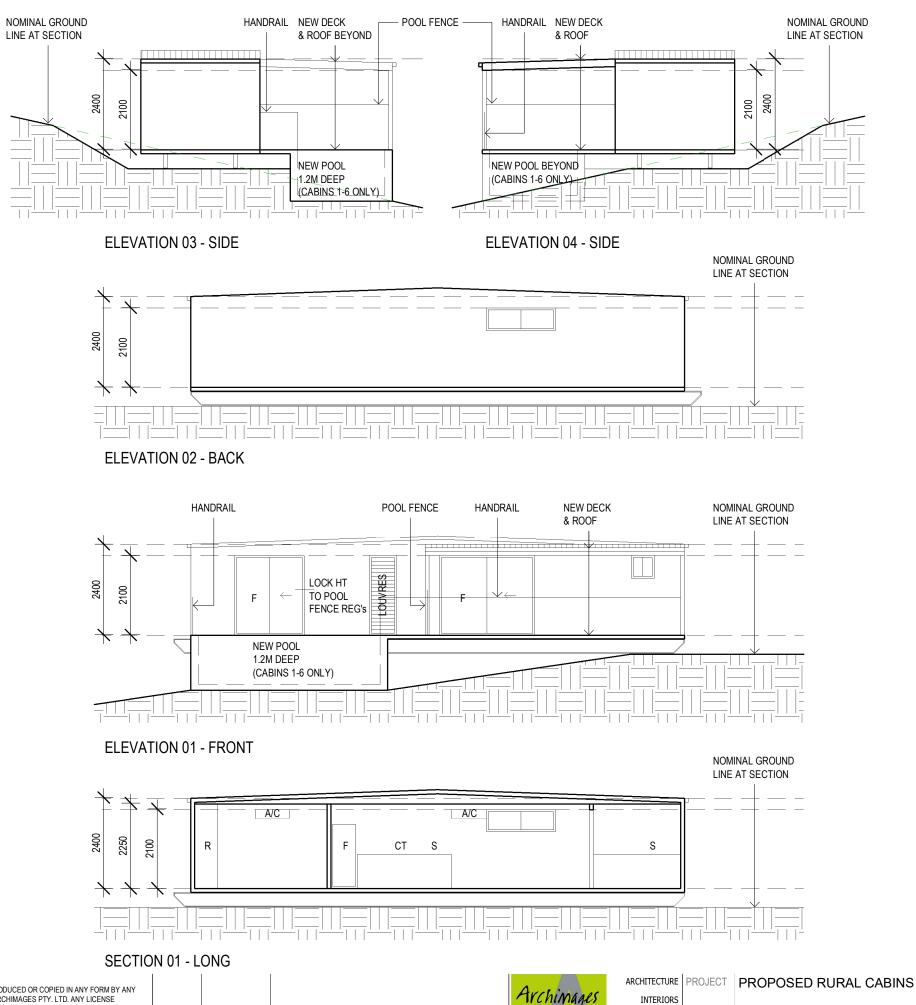


1 TYPICAL CABIN - POOL TO CABINS 1-6 ONLY

AREAS

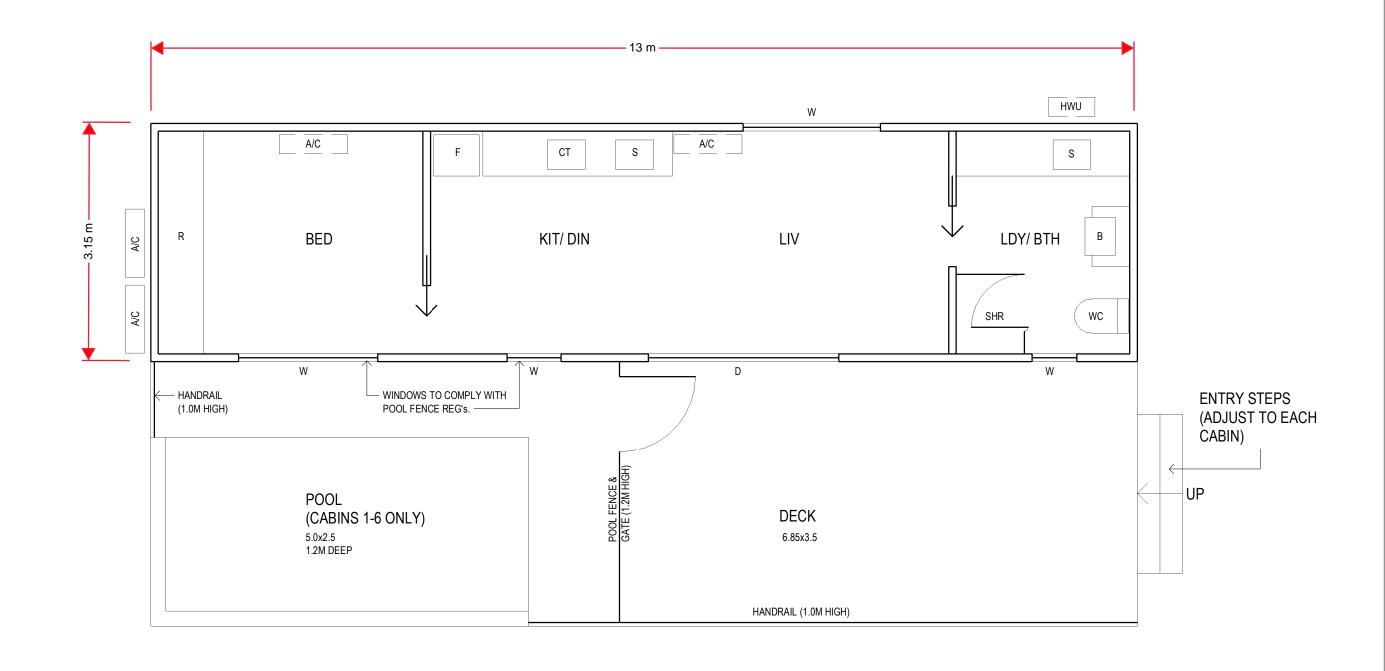INTERNAL - 38 SQM DECK - 33 SQM

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NOTE:

POOL TO CABINS 1 TO 6 ONLY

TYPICAL SCHEDULE OF FINISHES

WALLS - EARTH TONED COLORBOND METAL

ROOF MID TO DARK GREY/ EARTH TONED COLORBOND METAL

DECKS - TIMBER

POOL FENCE & HADRAILS - GLASS

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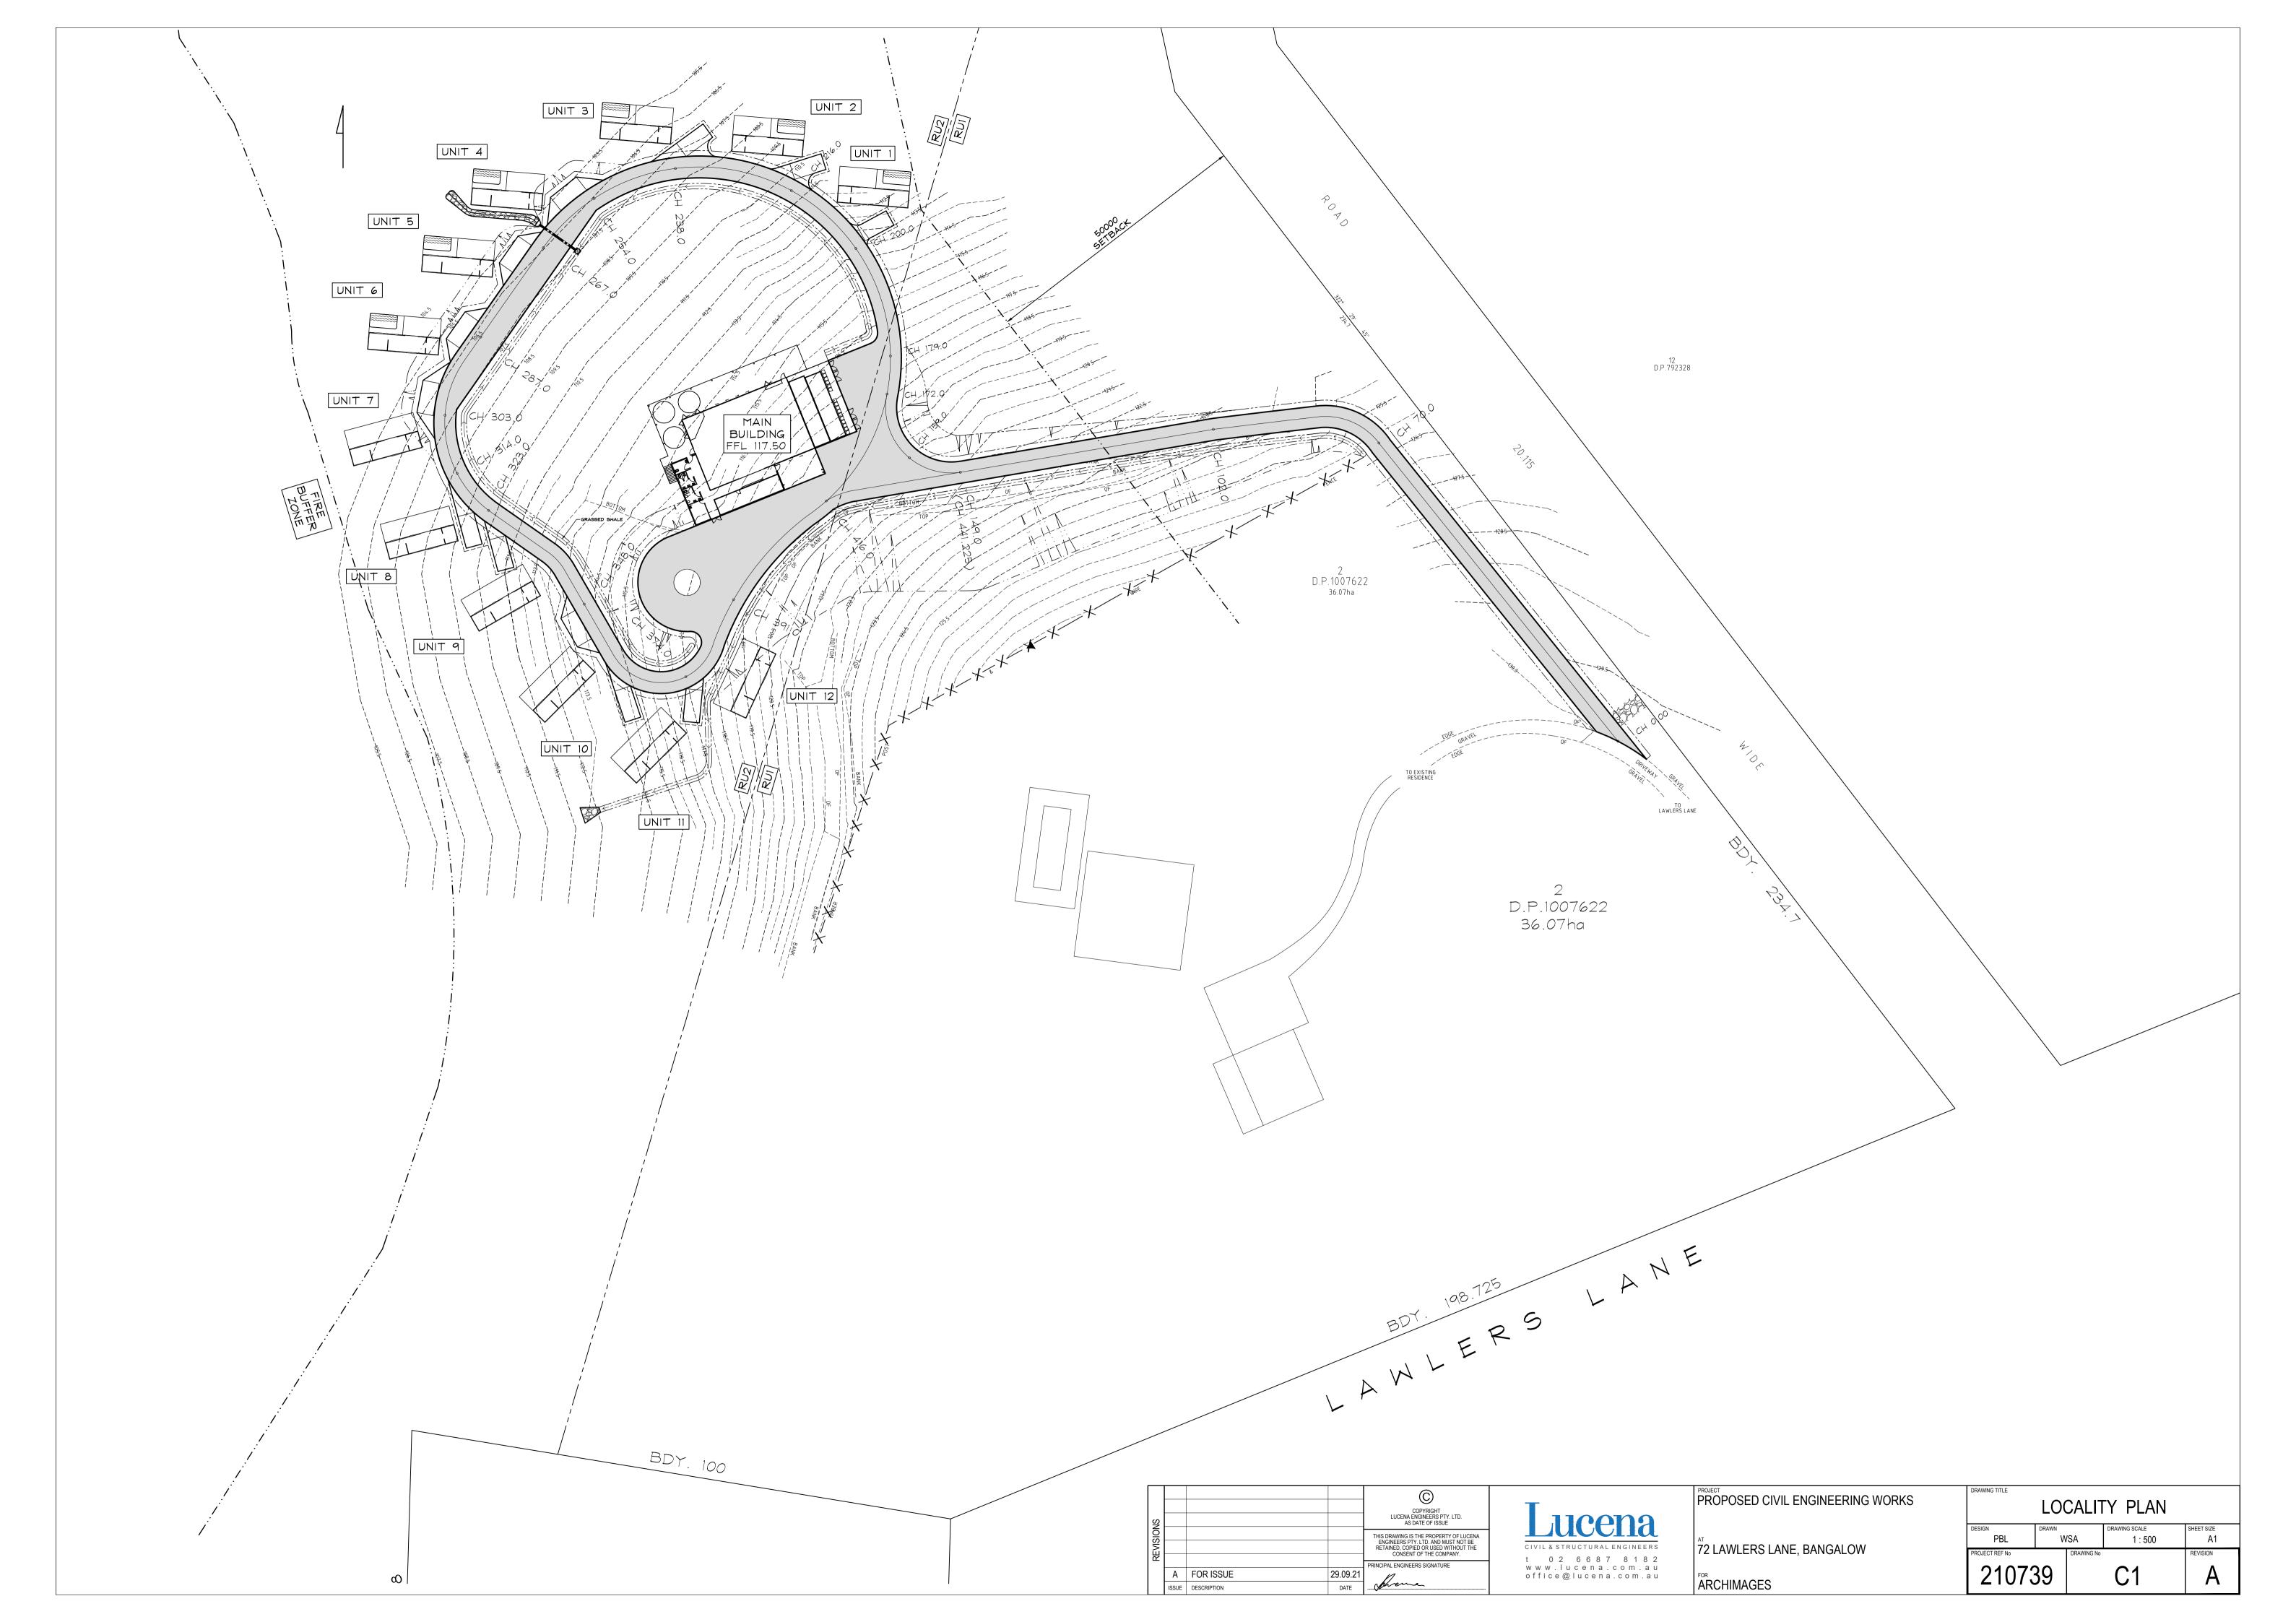
11/10/2021 DEVELOPMENT APPLICATION **ISSUE** DATE REVISION





	RALPH MAMONE
SS	72, LAWLERS LANE - BANGALOW

DESIGN	DEVELOPMENT
STAGE	APPLICATION
TITLE	CABIN - ELEVATIONS - PROPOSED


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DRIVEWAY LONGITUDINAL SECTION HORIZONTAL SCALE - 1 : 200 VERTICAL SCALE - 1 : 200

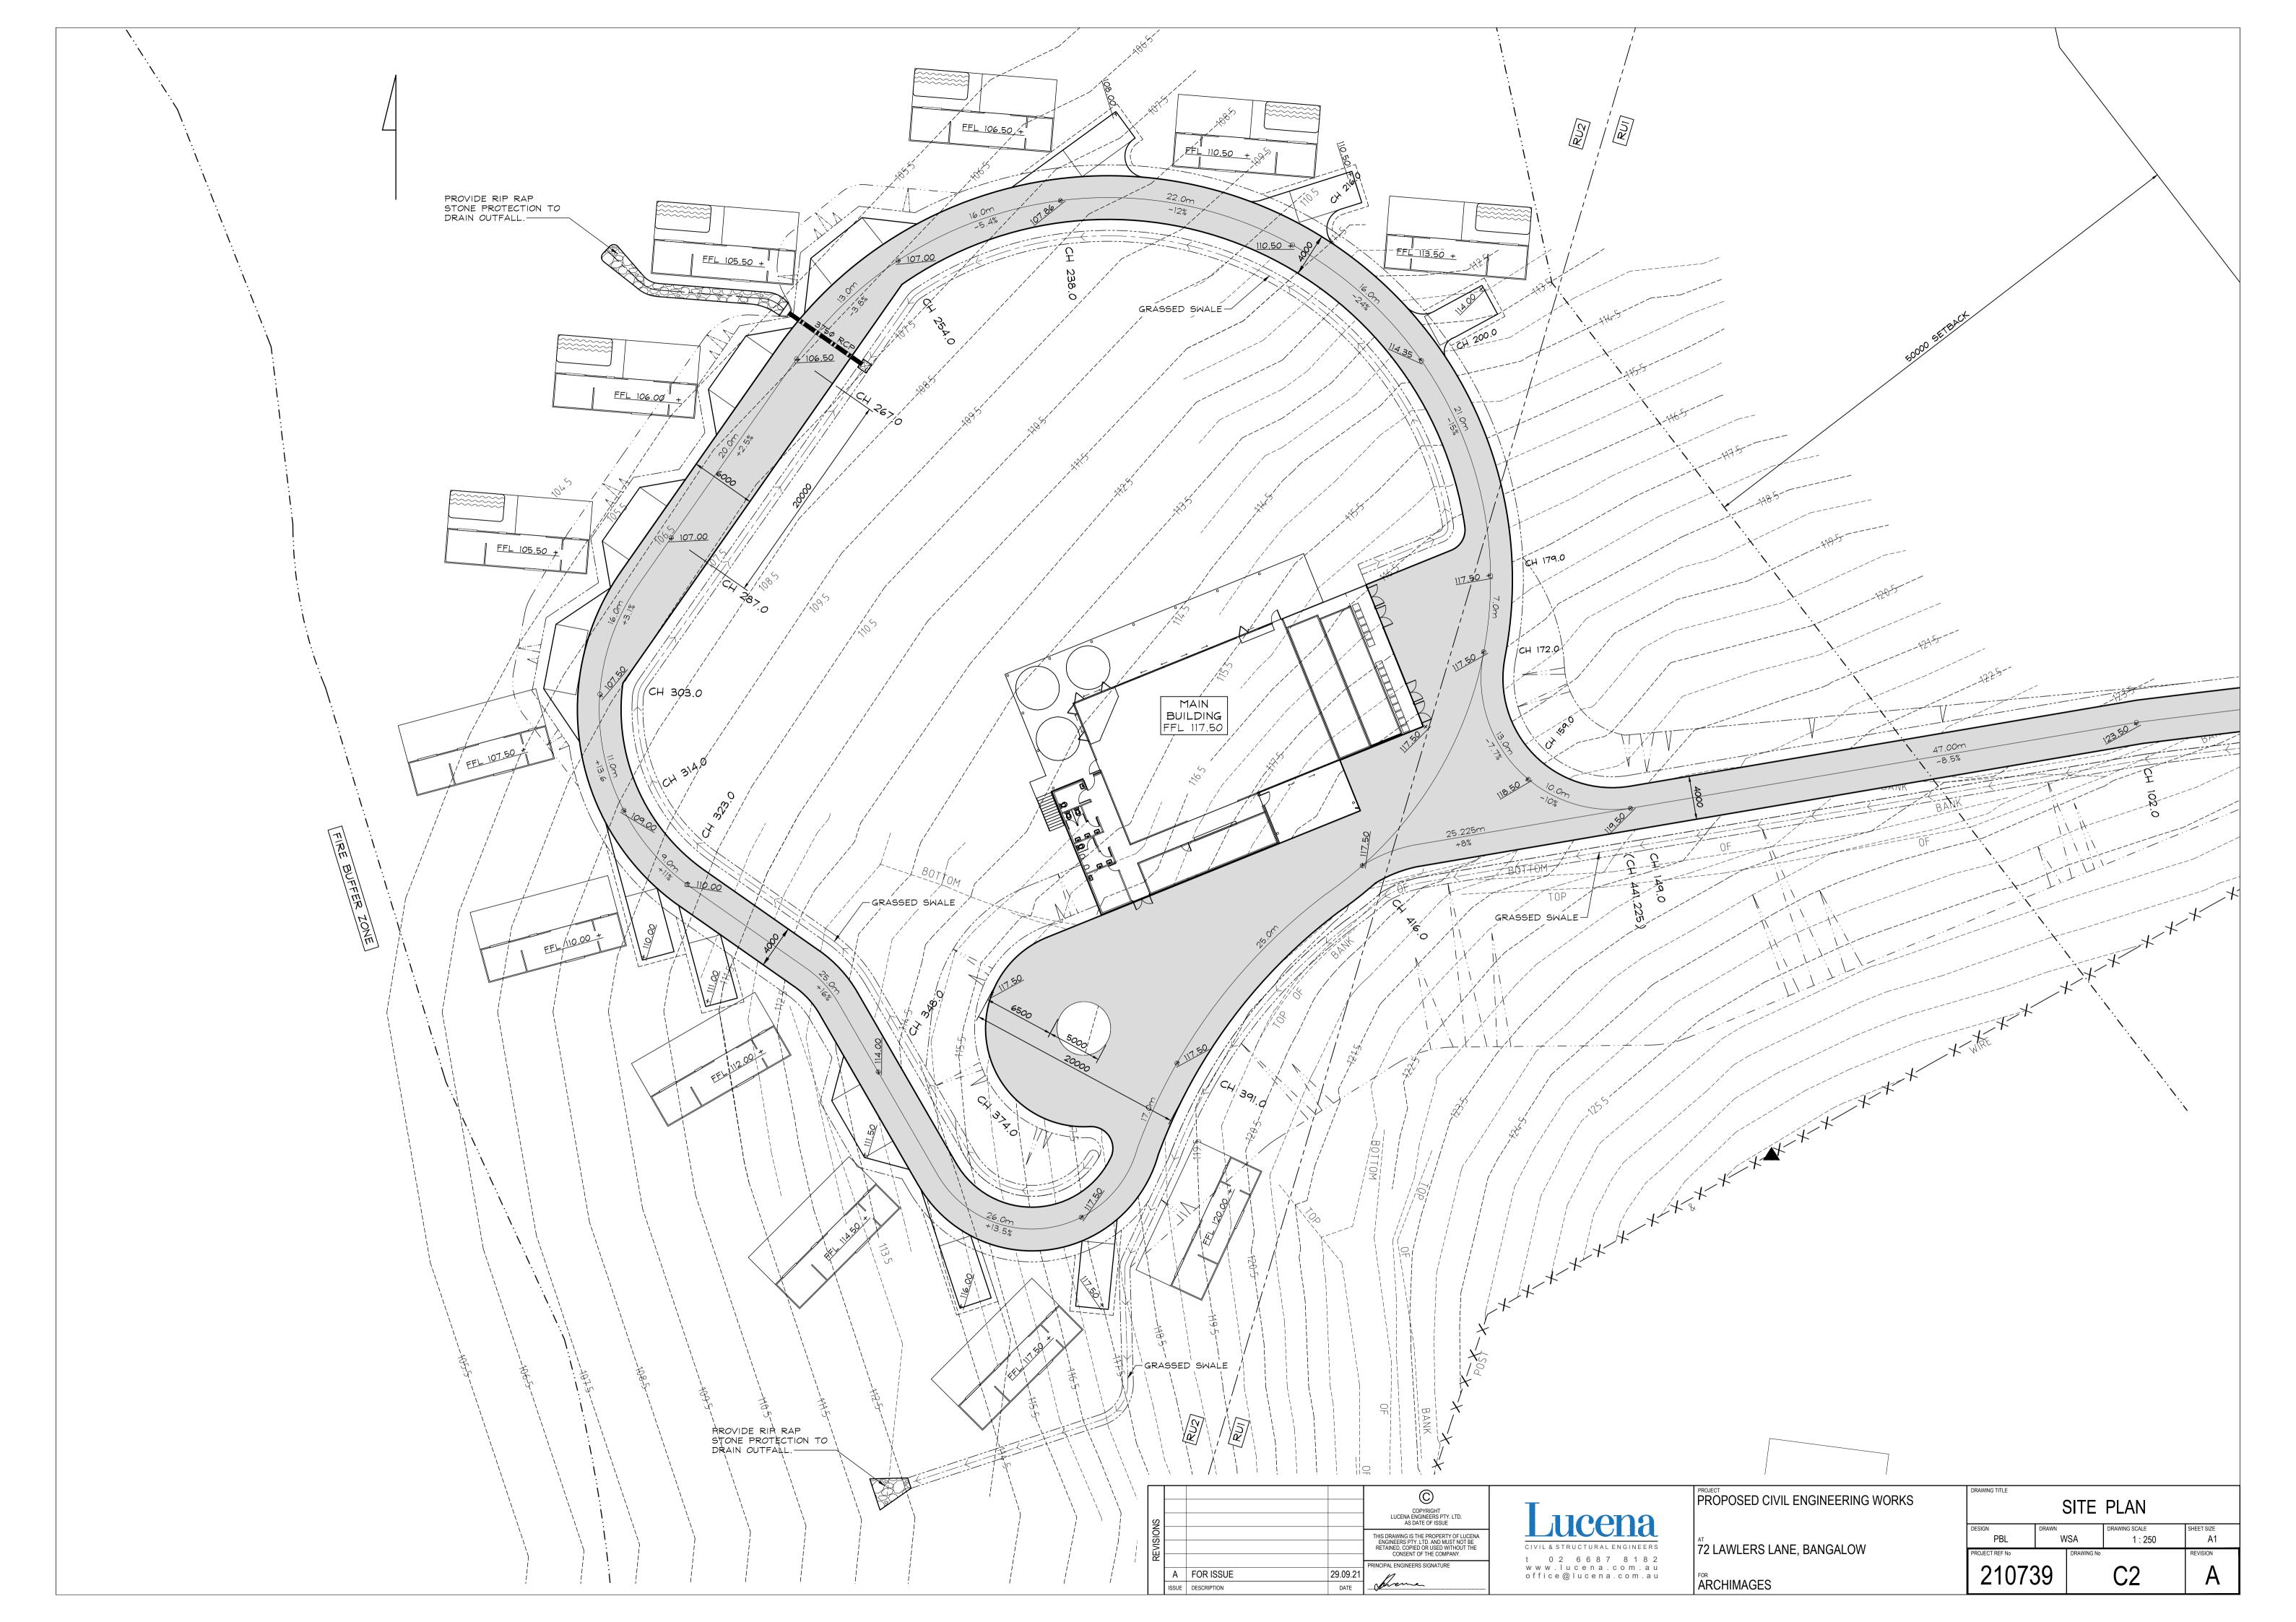


DRIVEWAY LONGITUDINAL SECTION HORIZONTAL SCALE - 1 : 200 VERTICAL SCALE - 1 : 200
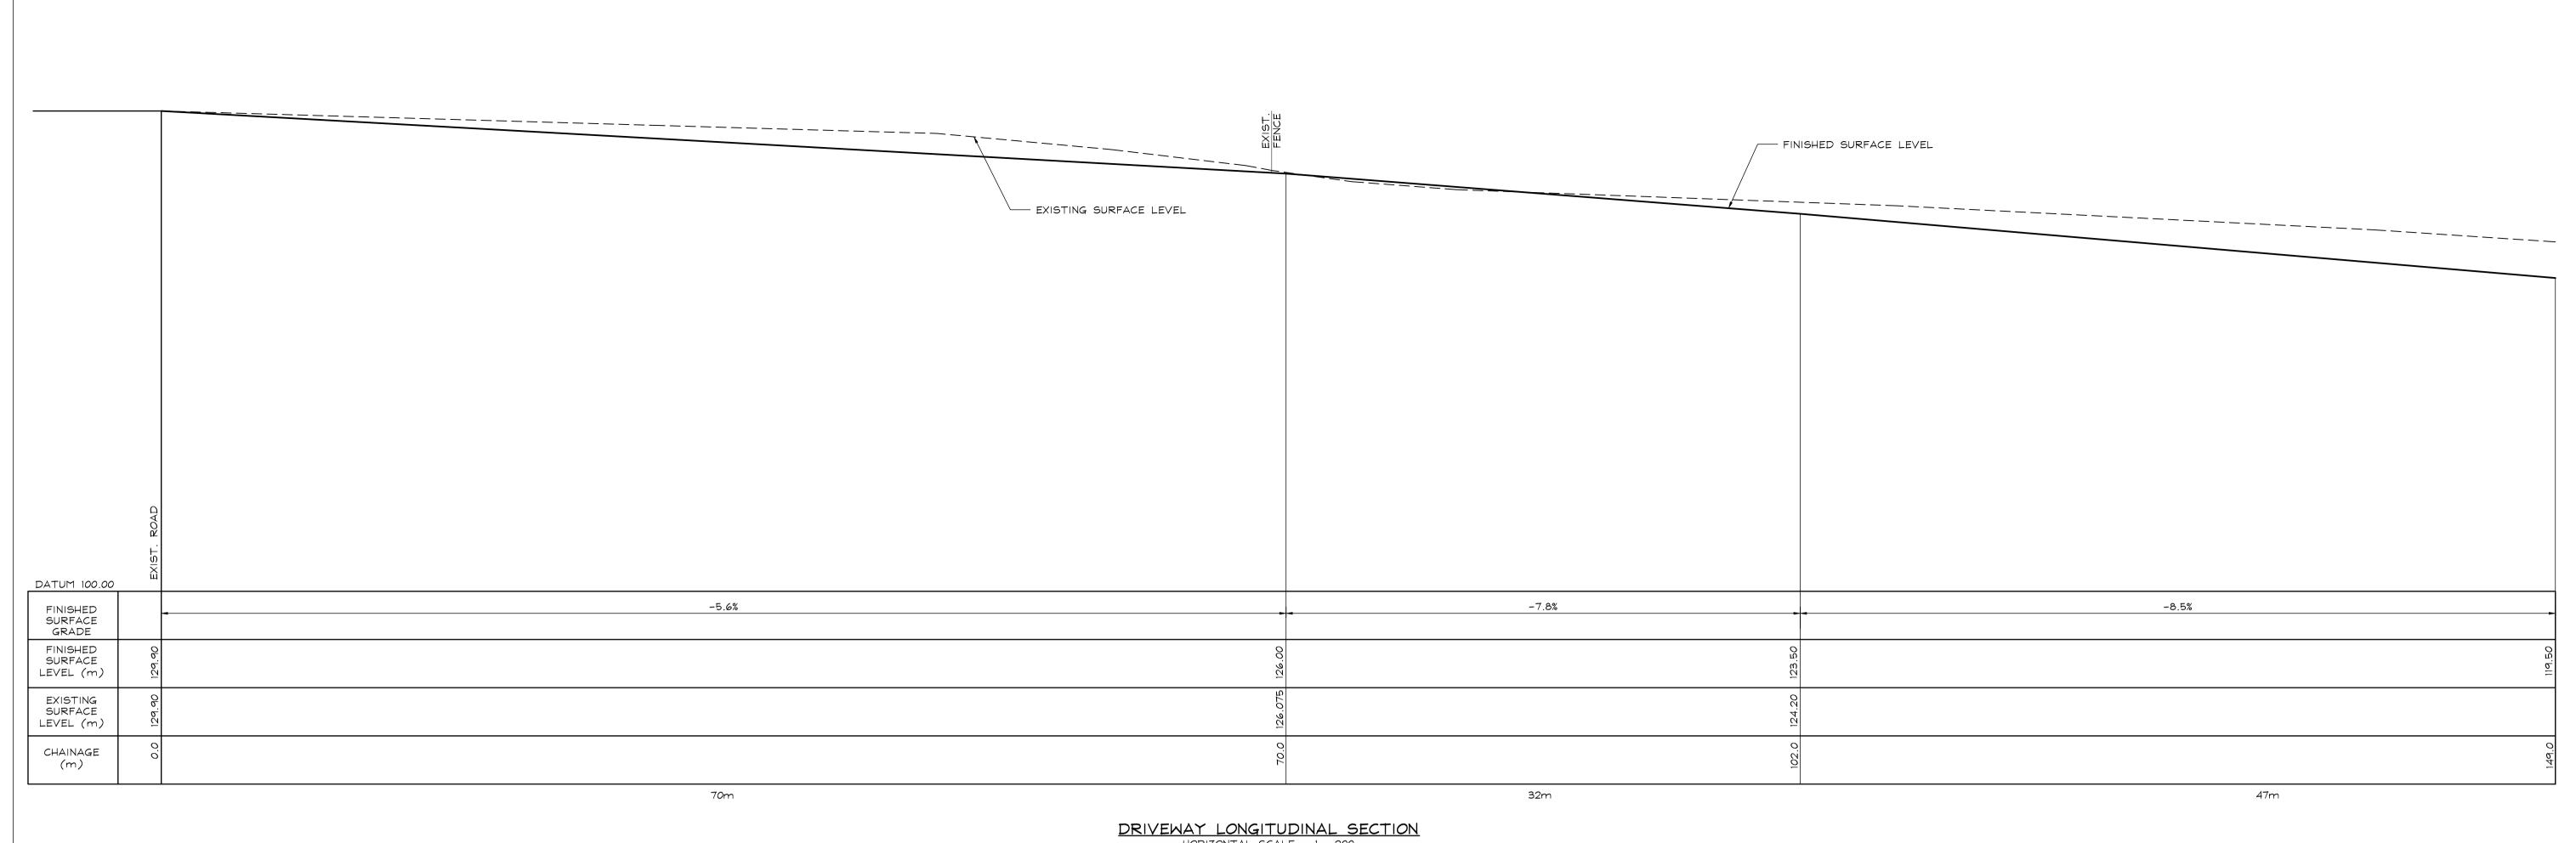
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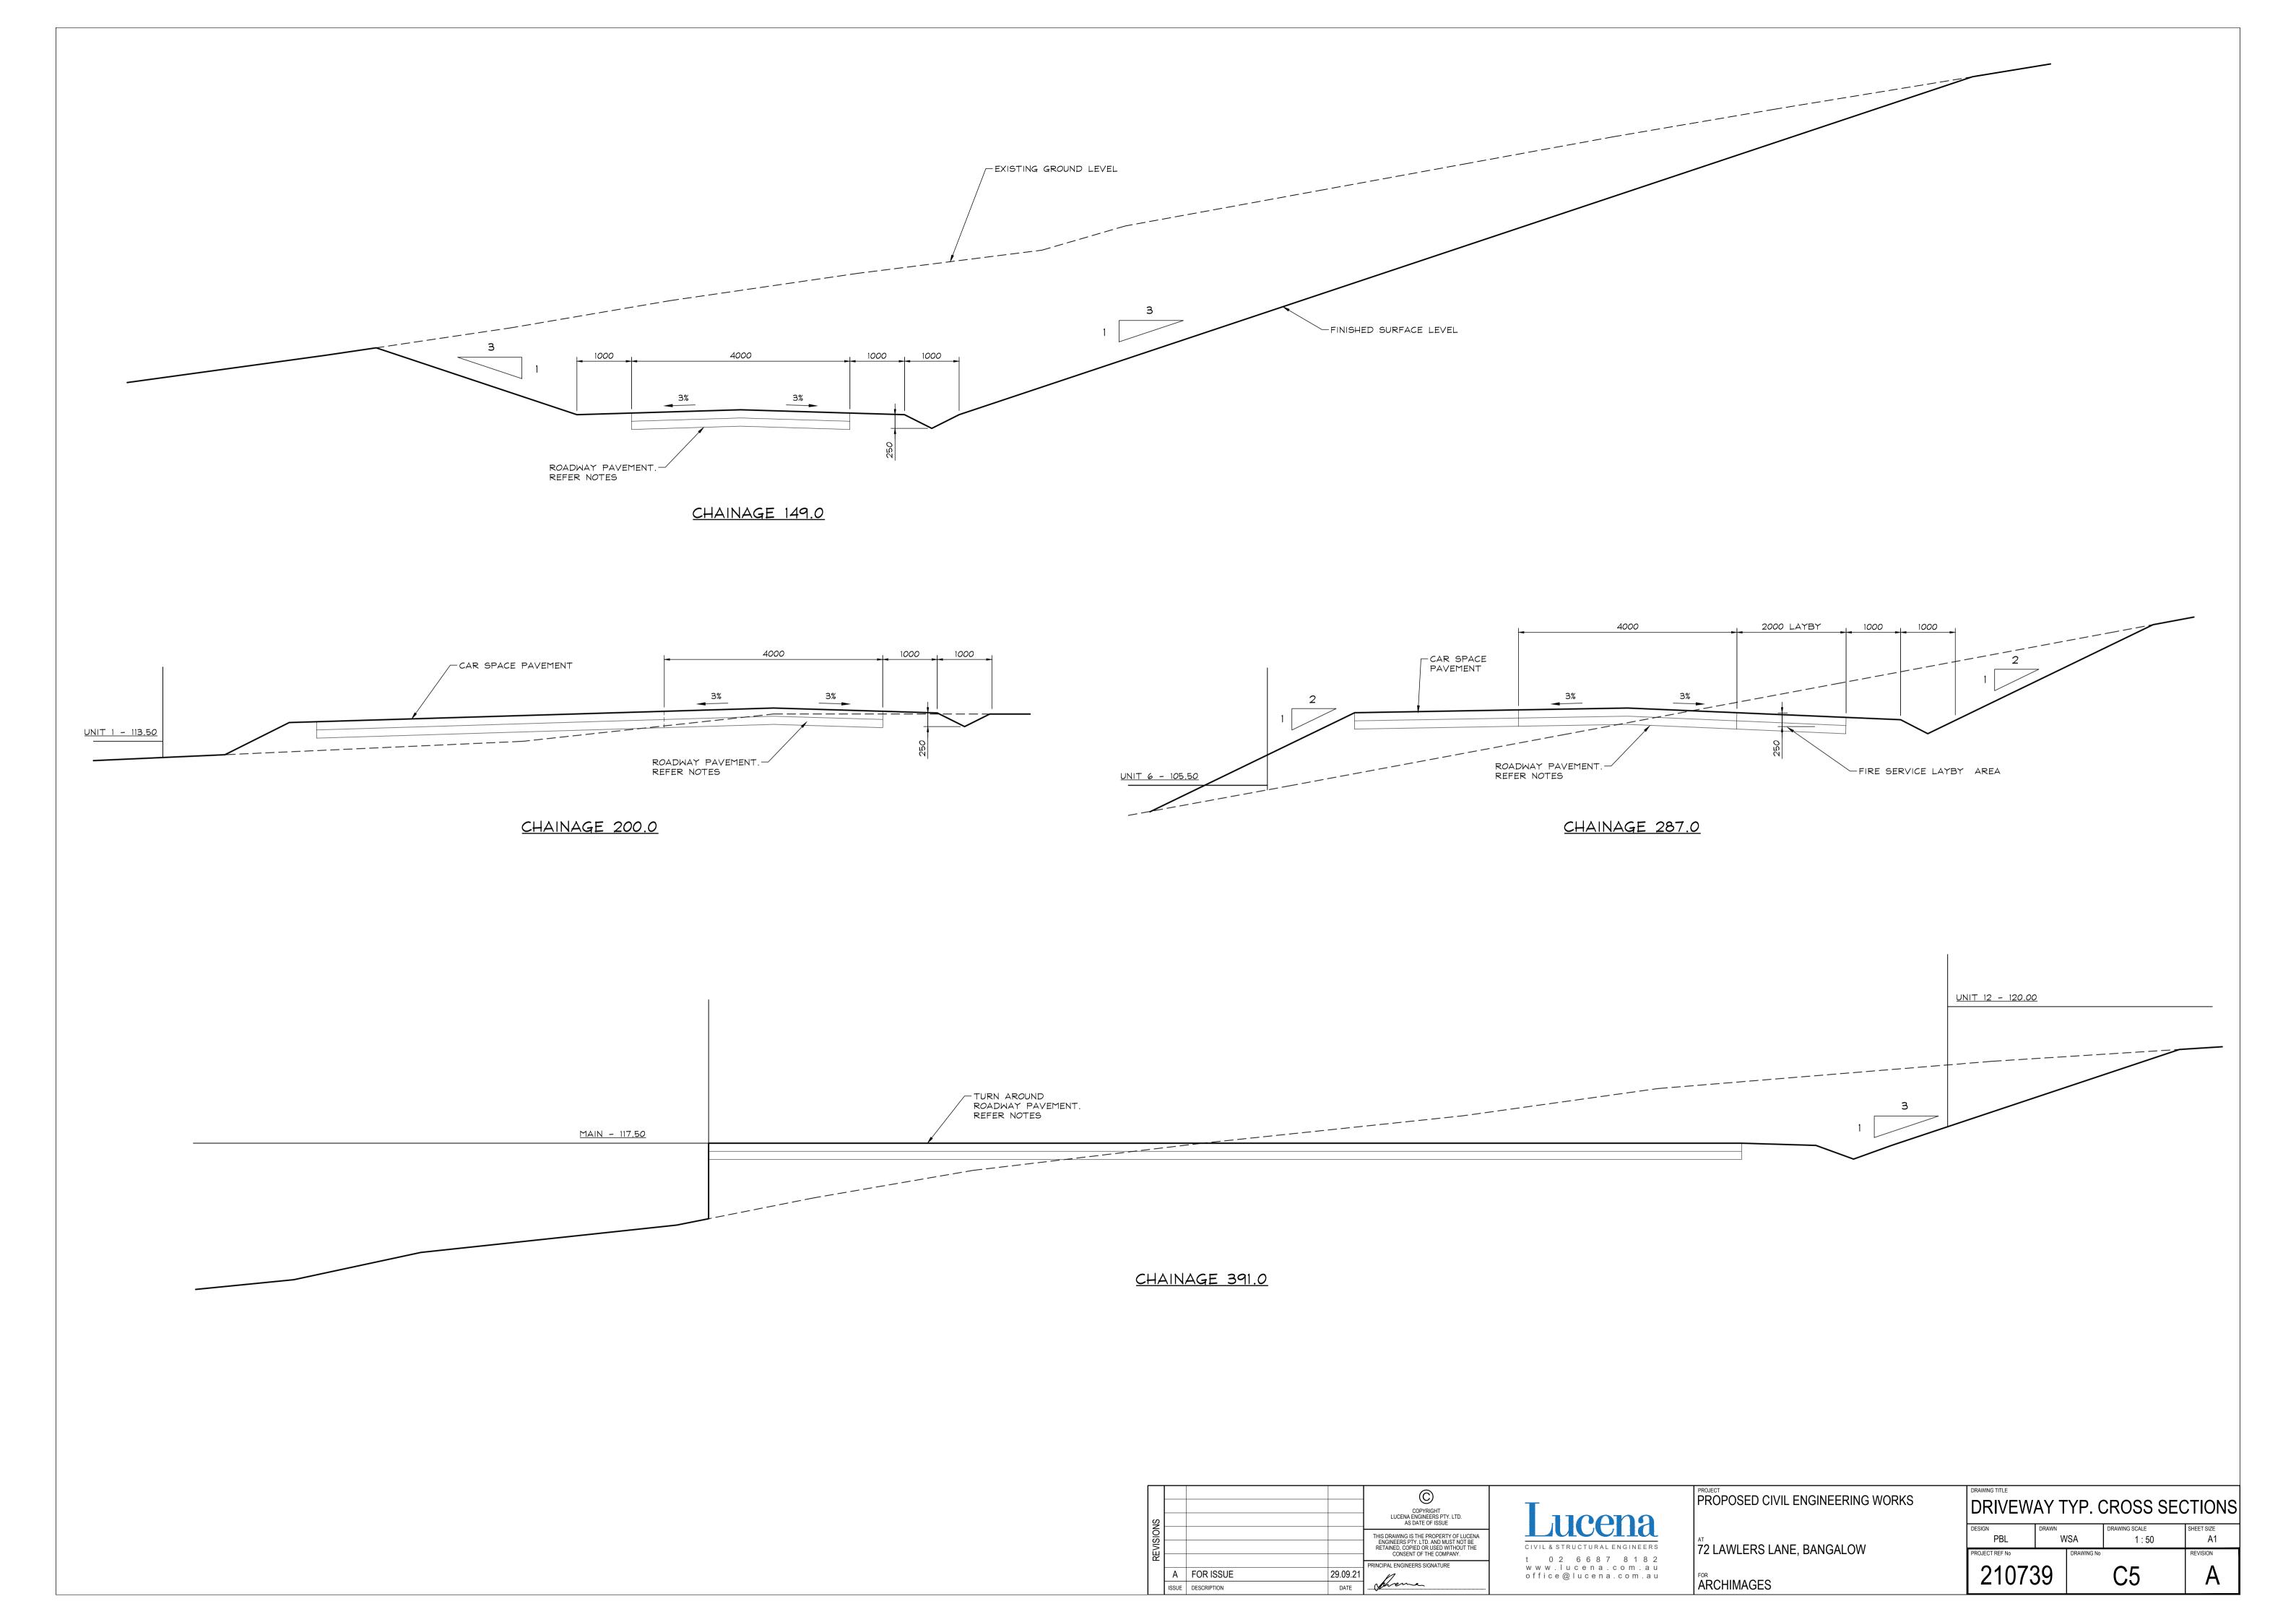
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72 LAWLERS LANE, BANGALOW	PROJECT REF No		DRAWING No		REVISION	
ARCHIMAGES	21073	39		C3	Α	




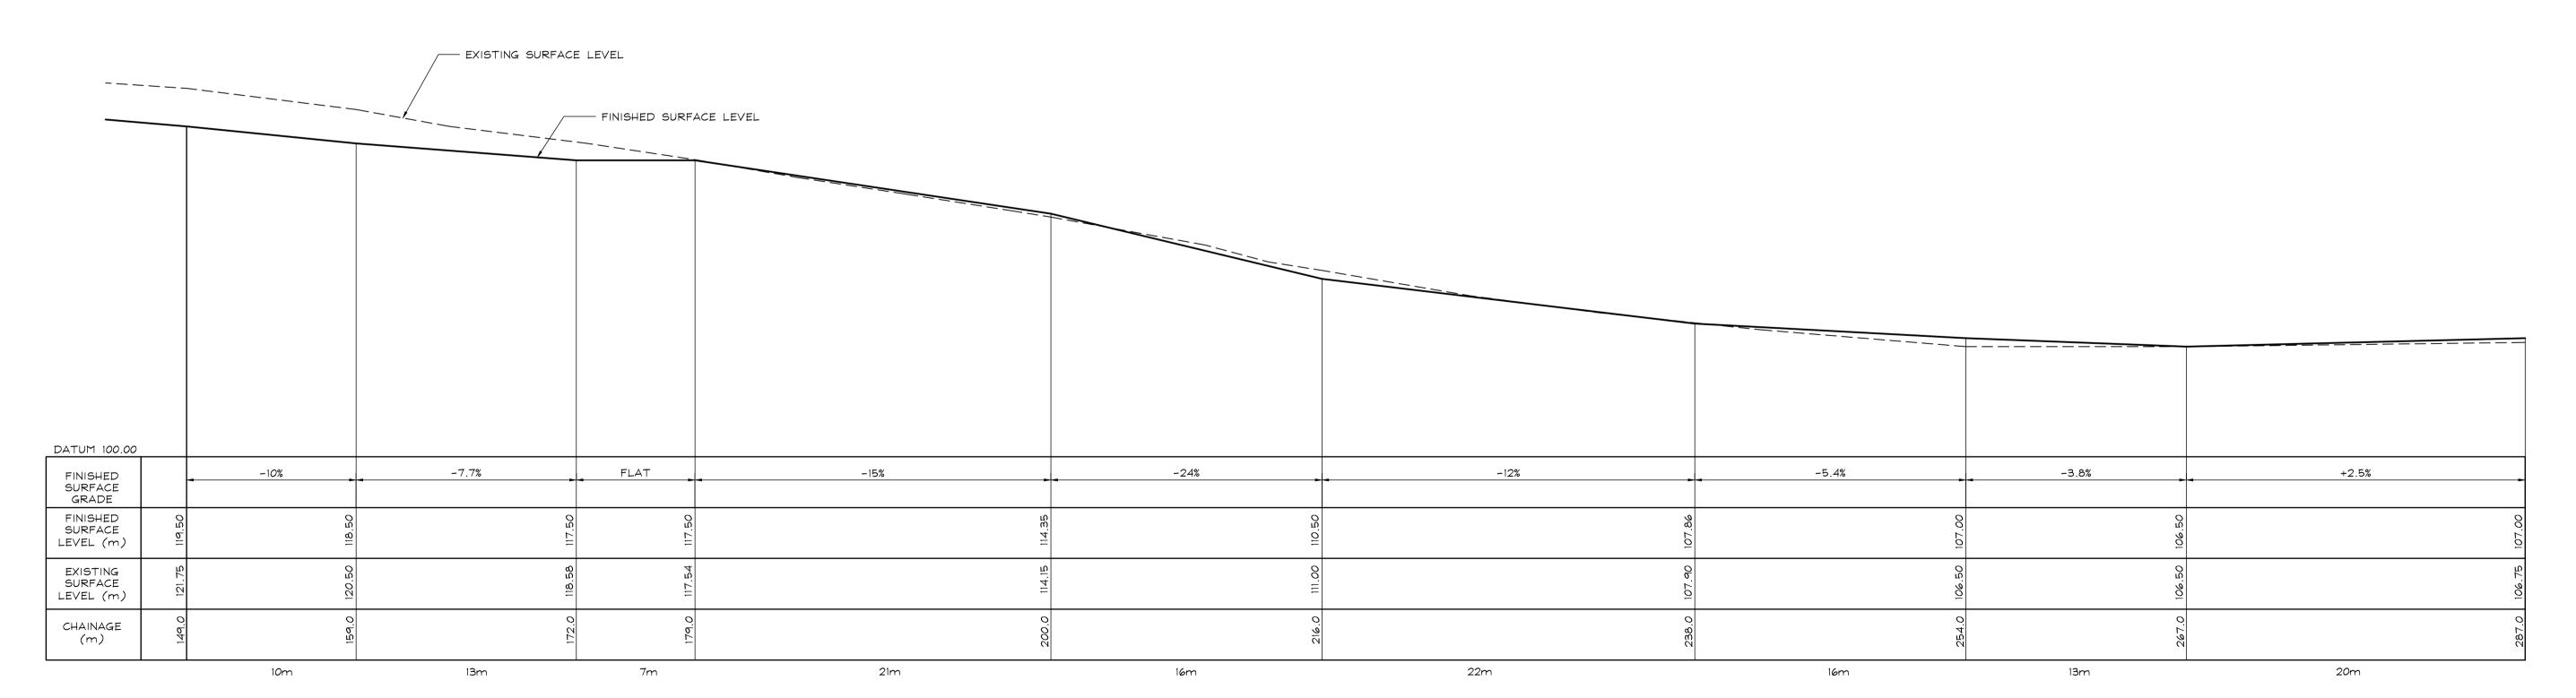

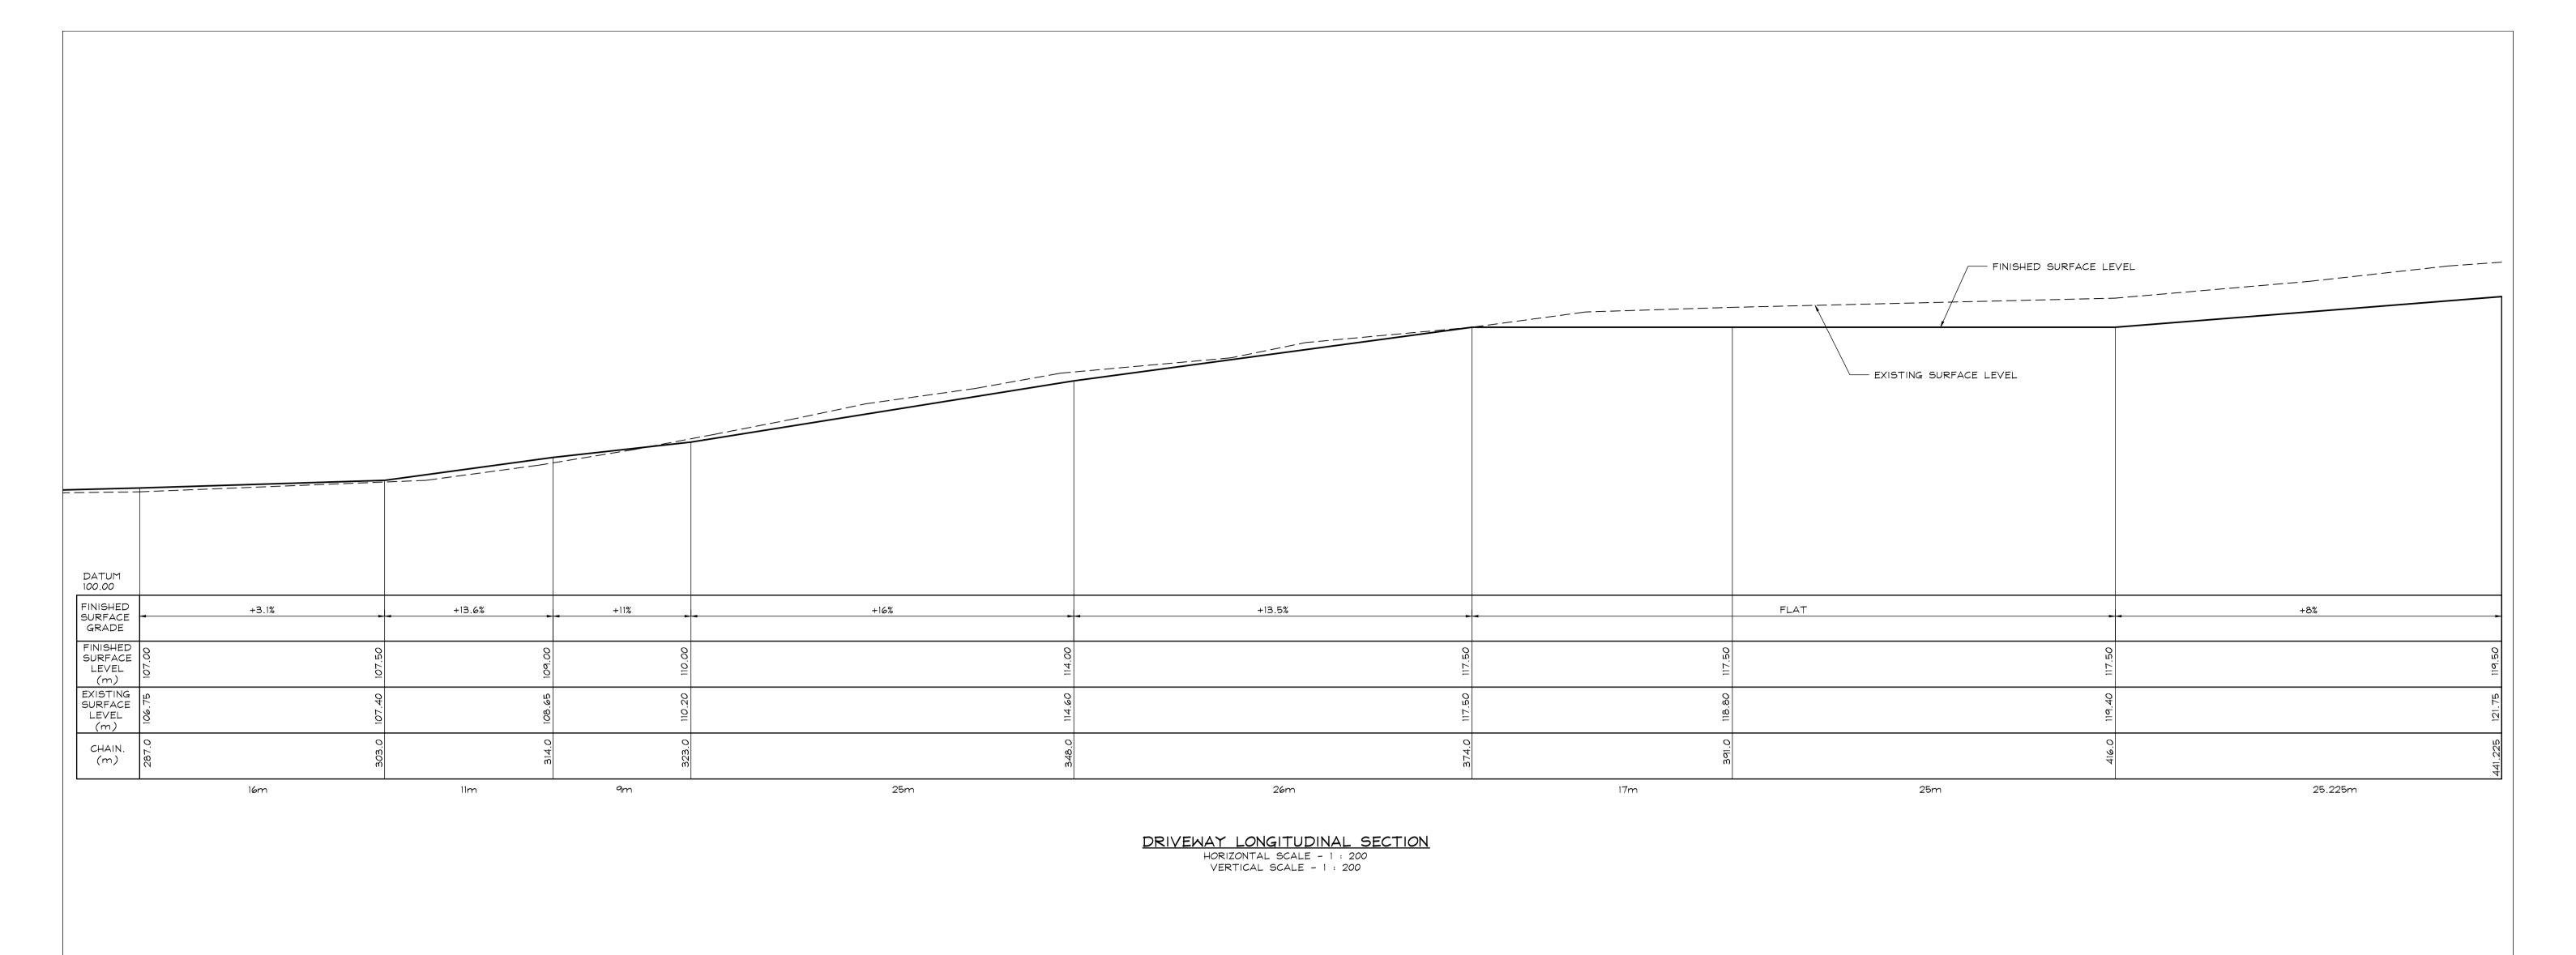
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DRIVEWAY LONG SECTION						
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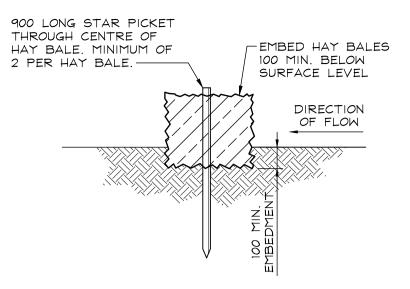




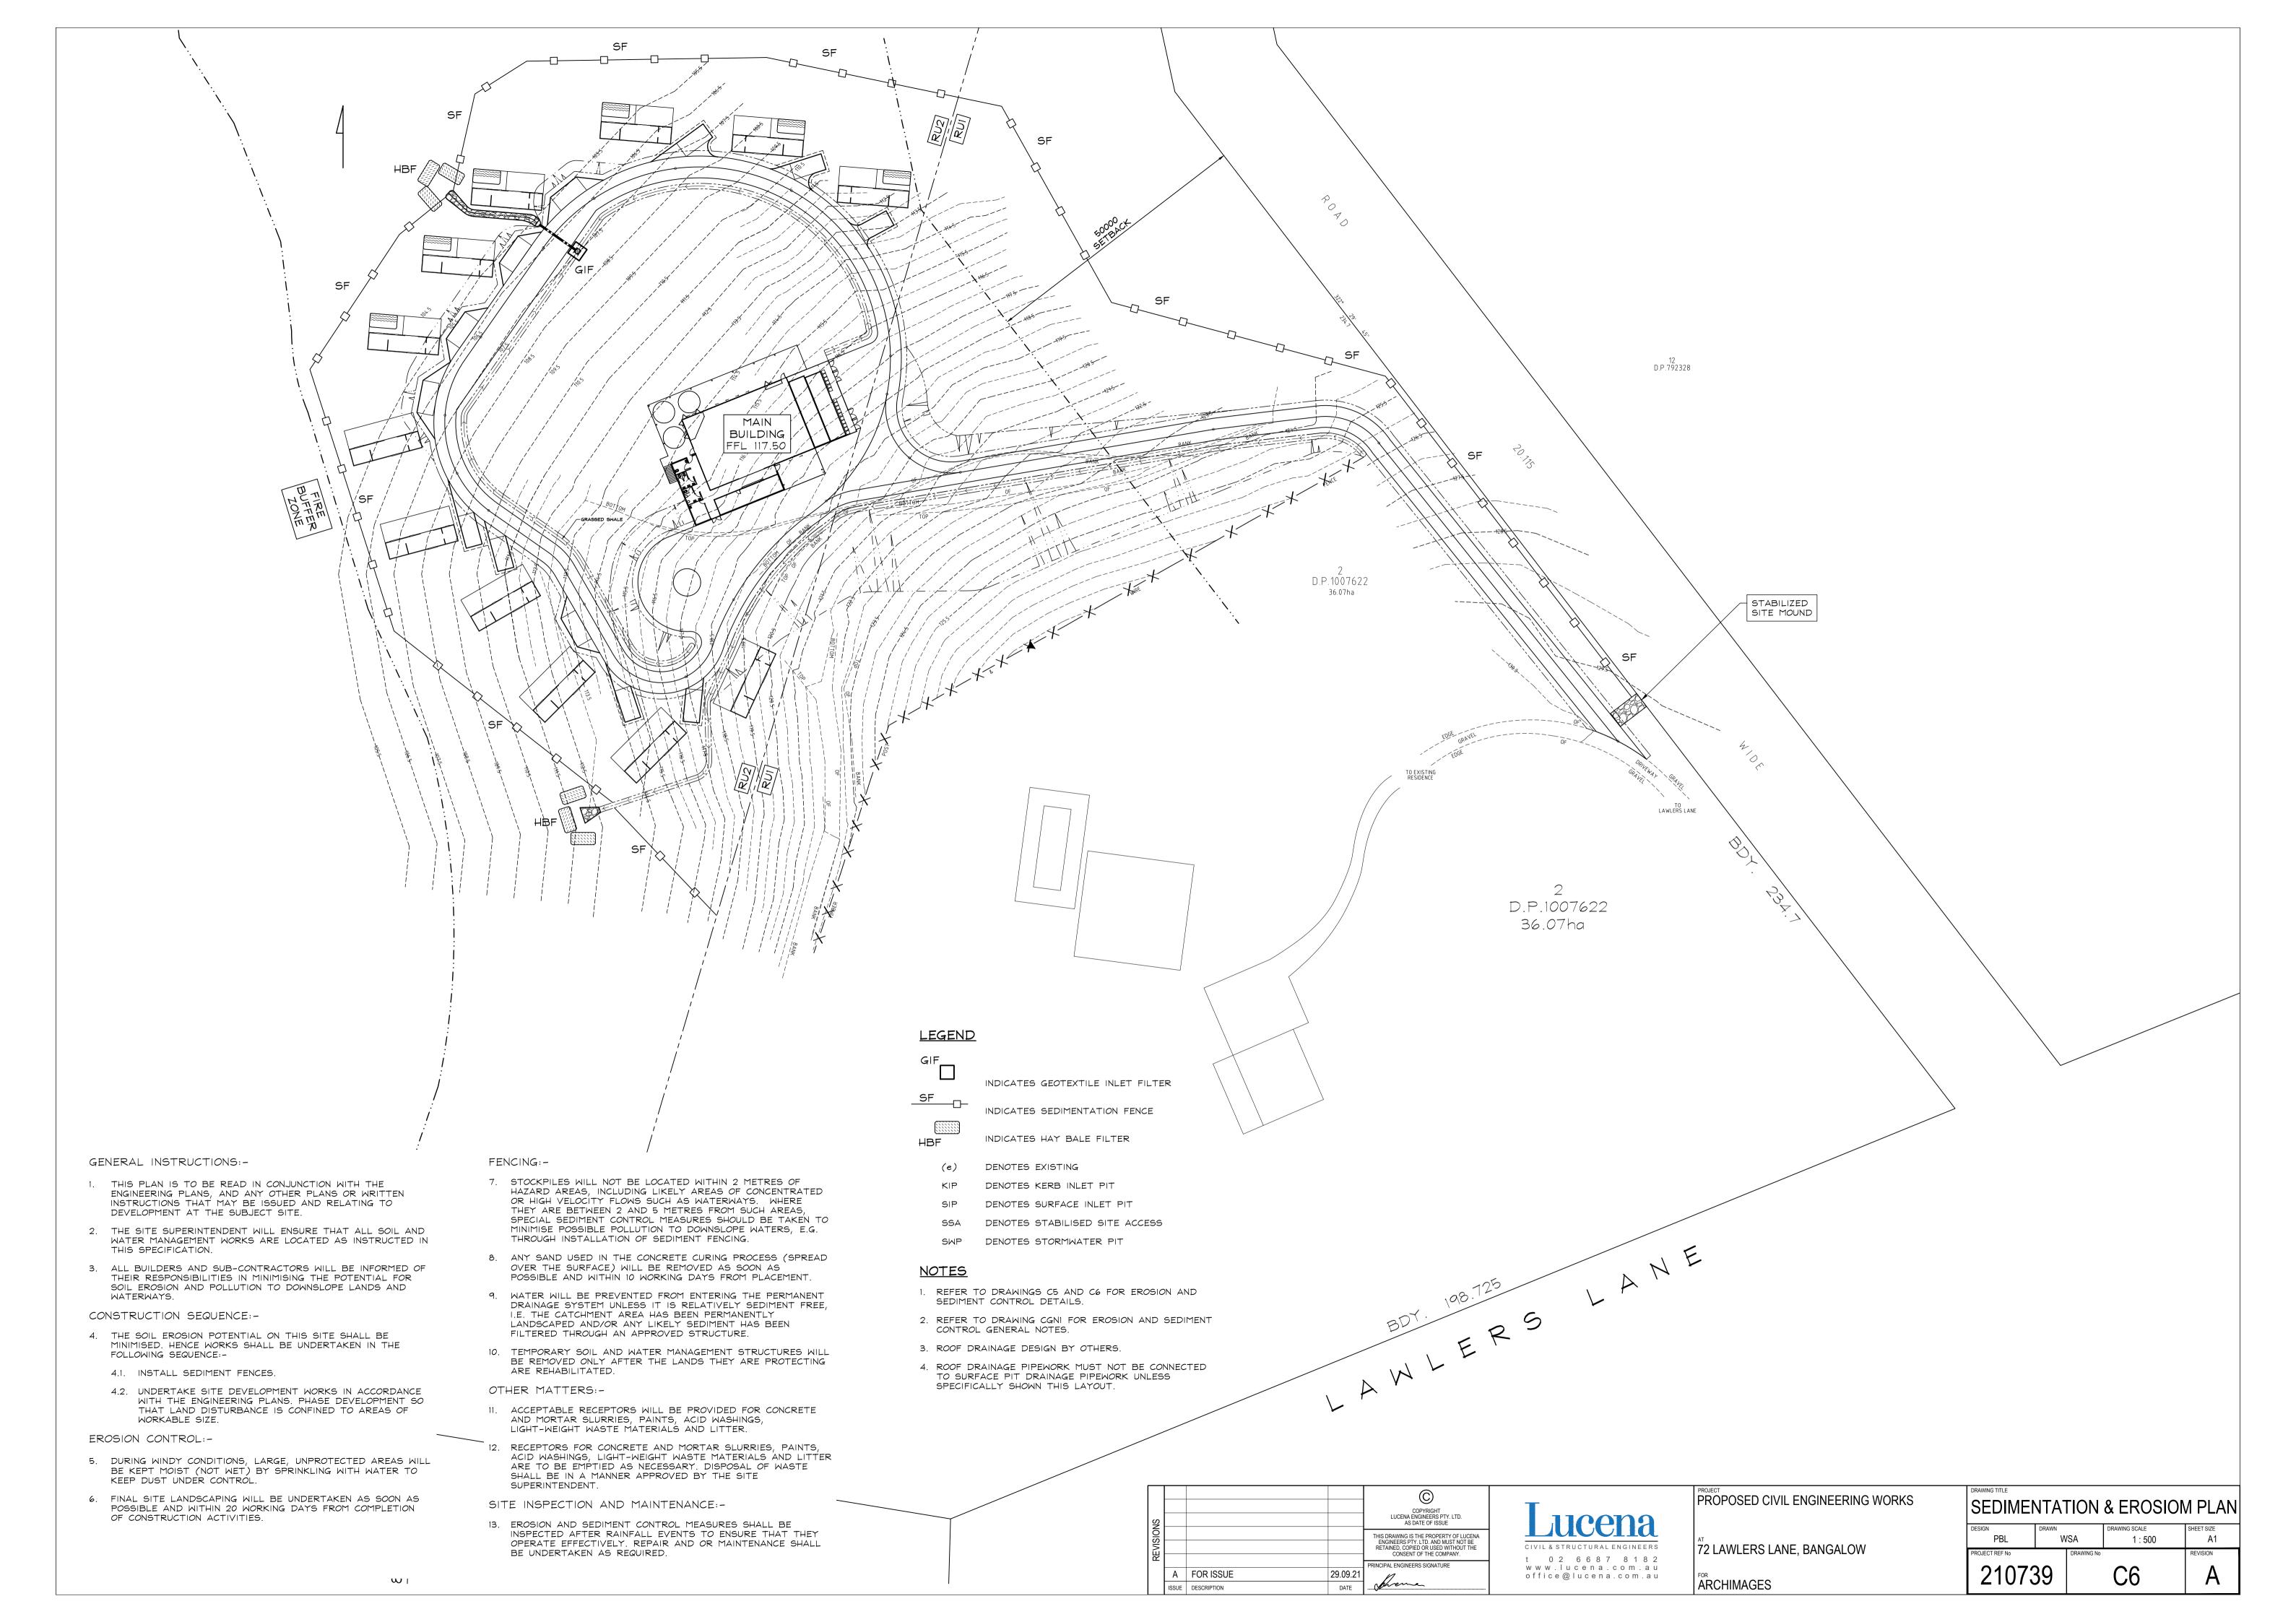


LETTERBOX STORMWATER PIT DETAIL

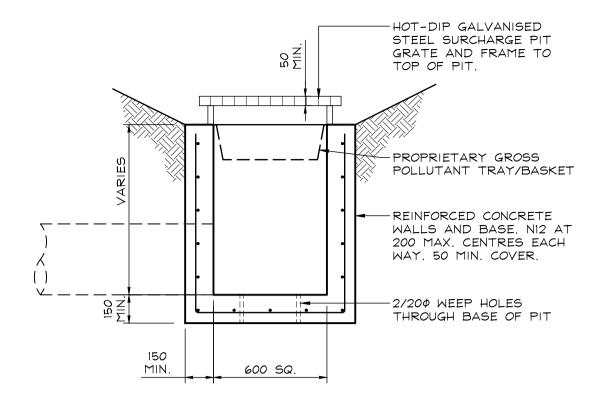ALTERNATIVELY, USE PROPRIETARY
PRE-CAST REINFORCED CONCRETE OR HDPE
PIT WITH HOT-DIP GALV. STEEL GRATE




TYPICAL HAY BALE FILTER 'HBF' DETAIL SCALE - 1:20

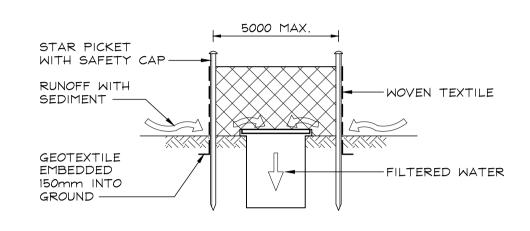

NOTES:
1. FABRICATE A SEDIMENT BARRIER MADE FROM GEOTEXTILE OR STRAW BALES SUPPORT GEOTEXTILE WITH MESH TIED TO POSTS AT IM CENTRES.

2. DO NOT COVER INLET WITH GEOTEXTILE.

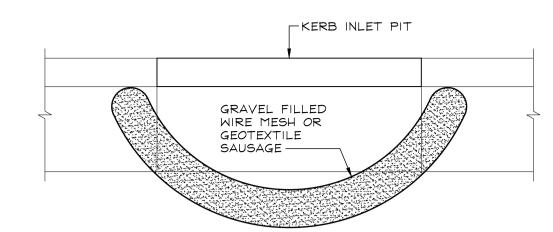


TYPICAL CONSTRUCTION SEQUENCE:-

AN EMERGENCY SPILLWAY.

- . FABRICATE A SLEEVE MADE FROM GEOTEXTILE OR WIRE MESH LONGER THAN THE LENGTH OF THE INLET PIT.
- 2. FILL THE SLEEVE WITH 25mm TO 50mm GRAVEL.
- 3. FORM AN ELLIPTICAL CROSS SECTION ABOUT 150mm
- HIGH x 400mm WIDE.
- 4. PLACE THE FILTER AT THE OPENING OF THE KERB INLET LEAVING A 100mm GAP AT THE TOP TO ACT AS
- 5. MAINTAIN THE OPENING WITH SPACER BLOCKS.
- 6. FORM A SEAL WITH THE KERBING AND PREVENT SEDIMENT BYPASSING THE FILTER.
- 7. FIT TO ALL KERB INLETS AT SAG POINTS.


MESH AND GRAVEL INLET FILTER 'MGIF' DETAIL
SCALE - 1:20

GEOTEXTILE INLET FILTER 'GIF' DETAIL SCALE - 1:20

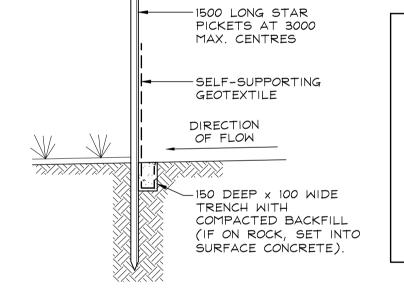

- TYPICAL CONSTRUCTION SEQUENCE:-
- CONSTRUCT SEDIMENT FENCE PARALLEL WITH CONTOURS ON SITE WHERE POSSIBLE.
- 2. DRIVE 1.5m LONG STAR PICKETS INTO GROUND AT 3m MAXIMUM
- 3. DIG A 150mm DEEP TRENCH ALONG THE UPSLOPE SIDE OF THE FENCE FOR THE BOTTOM OF THE FABRIC TO BE ENTRENCHED.
- 4. BACKFILL TRENCH OVER BASE OF FABRIC.
- 5. FIX SELF-SUPPORTING GEOTEXTILE TO UPSLOPE SIDE OF POSTS WITH WIRE TIES OR AS RECOMMENDED BY GEOTEXTILE MANUFACTURER.6. JOIN SECTIONS OF FABRIC AT A SUPPORT POST WITH 150mm OVERLAP.

TYPICAL SEDIMENT FENCE 'SF' DETAIL SCALE - 1:20

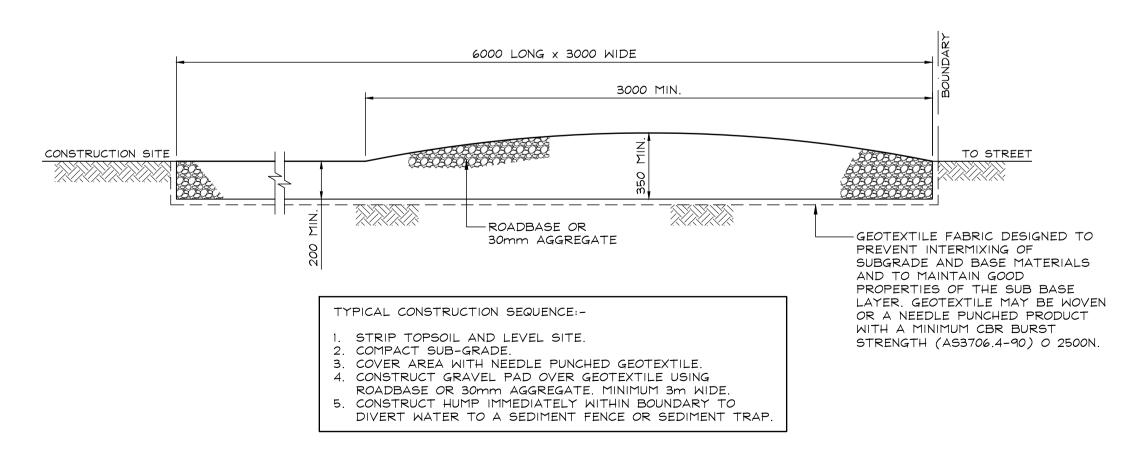

STABILISED SITE ACCESS 'SSA' DETAIL


SCALE - 1:20

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PROPOSED CIVIL ENGINEERING WORKS
72 LAWLERS LANE, BANGALOW
ARCHIMAGES

CIVIL DETAILS				
DESIGN PBL	DRAWN WSA		DRAWING SCALE 1:20	SHEET SIZE A1
PROJECT REF No		DRAWING No		REVISION
210739			C7	Α



Site Waste Management Plan for Building & Demo Works

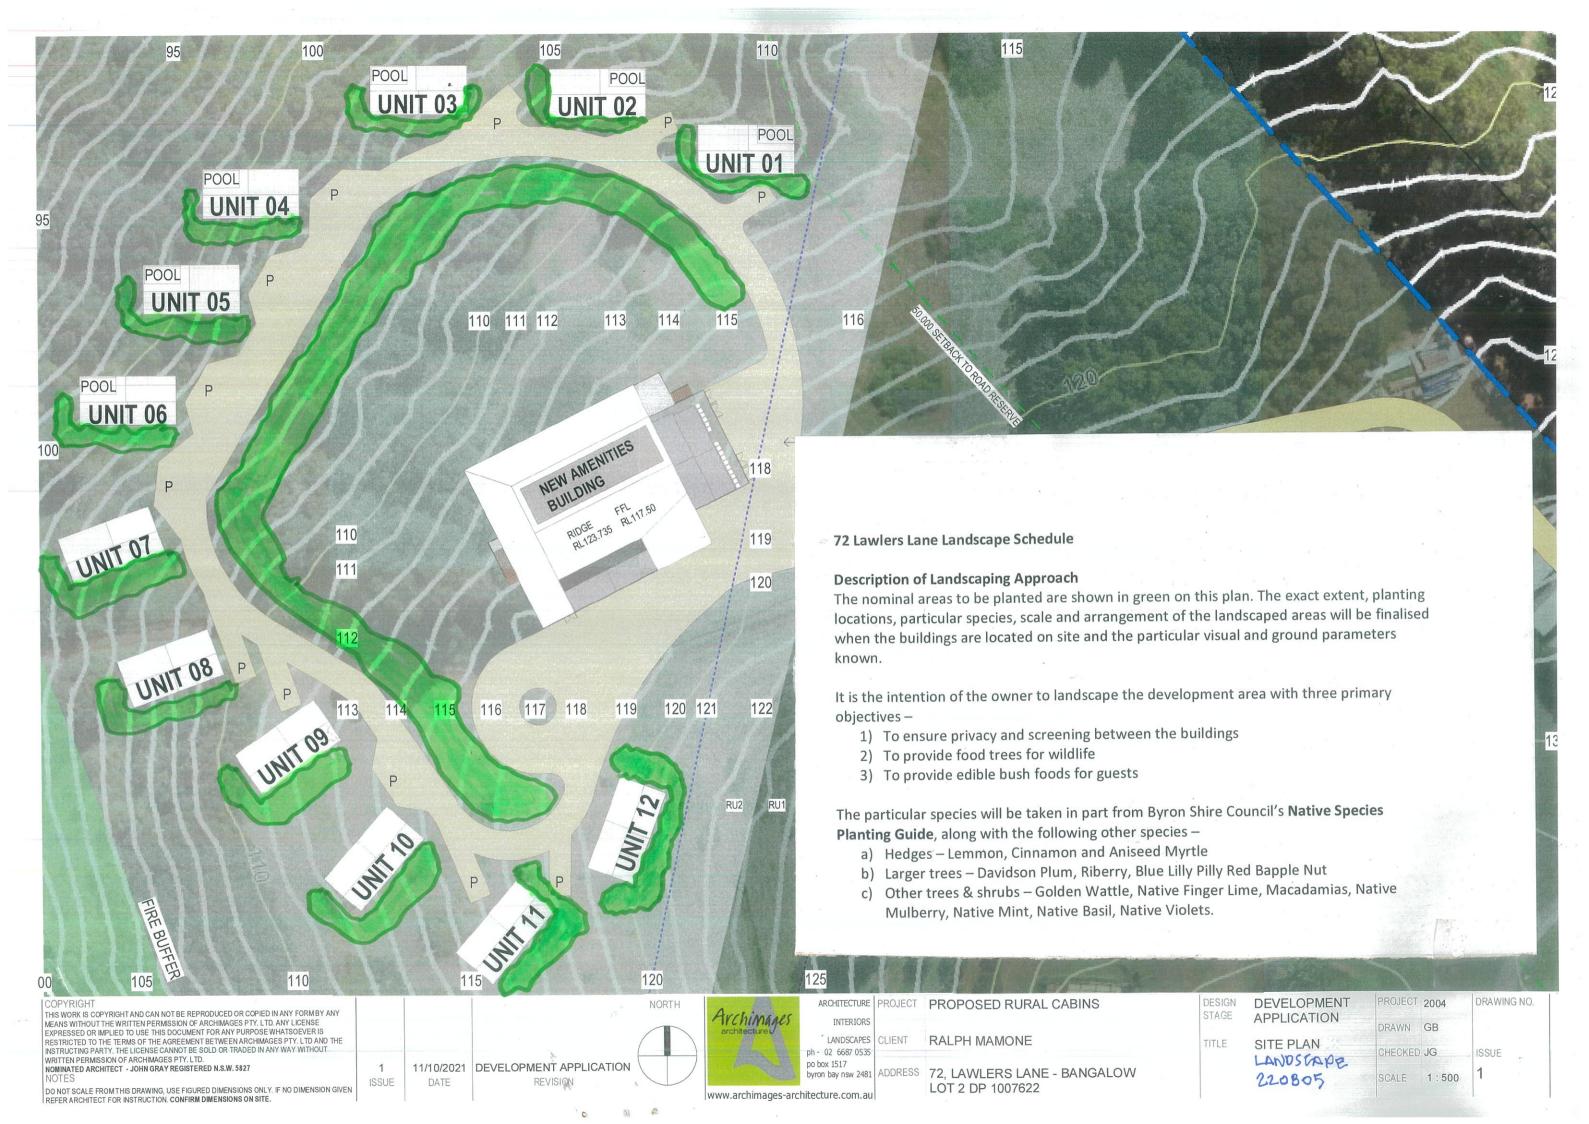NOTE: The level of detail required for the Site Waste Minimisation and Management Plan (SWMMP) will vary with the size and complexity of the proposed development. For example, a DA seeking consent for a dwelling house would normally require a very simple SWMMP, while a DA seeking consent for a large commercial or industrial complex is likely to require an extensive SWMMP that documents full details of proposed waste generation, management, recycling, storage and disposal measures.

Applicant Details			
Application No.	TBC		
Name	Joe Davidson - Town Planning Studio		
Address	72 Lawlers Lane, Bangalow		
Project Details			
Existing buildings and other structures	Dwelling		
currently on the site			
Description of proposed development	Tourist & visitor accomm and amenities		

This development achieves the waste objectives set out in the DCP. The details on this form are the provisions and intentions for minimising waste relating to this project. All records demonstrating lawful disposal of waste will be retained and kept readily accessible for inspection by regulatory authorities such as council, DECC or WorkCover NSW.

	Reuse	Recycling	Disposal	
Type of waste generated	Estimate Volume	Estimate Volume	Estimate Volume	Specify method of on-site reuse, contractor and recycling outlet and/or waste depot to be used
Excavation material	Nil	60m ³	Nil	Removal by tradesperson and used as fill off site
Timber (specify)	Nil	Nil	0.2m ³	Skip bin
Concrete	Nil	Nil	0.4m ³	Concrete disposal centre
Bricks	Nil	Nil	0.3m ³	Skip bin
Tiles	Nil	Nil	0.2m ³	Skip bin
Metal (specify)	Nil	0.3m ³	Nil	Removal by tradesperson or skip
Glass	Nil	Nil	Nil	Recycling centre
Plasterboard (offcuts)	Nil	Nil	0.2m ³	Skip bin
Fixtures and fittings	Nil	Nil	0.2m ³	Removal by tradesperson or skip
Floor coverings	Nil	Nil	0.2m ³	Skip bin
Packaging (used pallets, pallet wrap)	0.4m ³	Nil	0.2m ³	Skip bin
Garden organics	Nil	Nil	Nil	N/A
Containers (cans, plastic, glass)	Nil	0.2m ³	0.1m ³	Skip bin or recycling centre

Paper/cardboard	Nil	0.2m ³	0.1m ³	Skip bin or recycling centre
Residual waste	Nil	Nil	0.1m ³	Skip bin
Hazardous/special waste (specify)	Nil	Nil	Nil	N/A

Construction Design (all types of development)

Outline how measures for waste avoidance have been incorporated into the design, material purchasing and construction techniques of the development (refer to Section B8.3.2):

Materials

- Accurate estimates of volumes of materials.
- Reuse/recycling opportunities maximised.
- Use of recycled and/or prefabricated building components.
- Delivery of materials to be on an 'as needed' basis to prevent weathering and moisture damage.
- Cover material stockpiles with reusable plastic to prevent weathering and moisture damage.
- All waste to be transported to a lawful waste facility.

Lifecycle

- Use of durable materials as appropriate.
- Use of self maintaining materials as appropriate.
- Use of self cleaning materials as appropriate.
- Provision of a maintenance regime as opposed to a replacement regime.

Detail the arrangements that would be appropriate for the ongoing use of waste facilities as provided in the development. Identify each stage of waste transfer between residents' units/commercial tenancies and loading into the collection vehicle, detailing the responsibility for and location and frequency of, transfer and collection.

- Provide buildings within the development site with a bin storage area that can contain serviced wheelie bins.
- The occupants of tenancy will be responsible for the placement of bins at the roadside each week or fortnight in accordance with Byron Shire Council's collection service for each bin type
- Upon removal of waste, the occupants will be responsible for returning each bin to the bin storage area.

Plans and Drawings (All Developments)

The following checklists are designed to help ensure SWMMPs are accompanied by sufficient information to allow assessment of the application.

Drawings are to be submitted to scale, clearly indicating the location of and provisions for the storage and collection of waste and recyclables during:

1. Demolition; 2. Construction; 3. Ongoing operation.

Demolition	
Size and location(s) of waste storage area(s)	See plans
Access for waste collection vehicles	See plans
Areas to be excavated	See plans
Types and numbers of storage bins likely to be required	Skip on demand
Signage required to facilitate correct use of storage facilities	N/A

Construction	
Size and location(s) of waste storage area(s)	See plans
Access for waste collection vehicles	See plans
Areas to be excavated	See plans
Types and numbers of storage bins likely to be required	Skip on demand and disposal to accredited asbestos facility
Signage required to facilitate correct use of storage facilities	N/A

Ongoing operation	
Space	
Size and location(s) of waste storage areas	Yes
Recycling bins placed next to residual waste bins	Yes
Space provided for access to and the manoeuvring of bins/equipment	Yes
Any additional facilities	N/A
Access	
Access route(s) to deposit waste in storage room/area	Yes
Access route(s) to collect waste from storage room/area	Yes
Bin carting grade	Gentle grade
Location of final collection point	Roadside
Clearance, geometric design and strength of internal access driveways and roads	Suitable
Direction of traffic flow for internal access driveways and roads	Two way
Amenity	
Aesthetic design of waste storage areas	Yes
Signage – type and location	N/A
Construction details of storage rooms/areas (including floor, walls, doors, ceiling design, sewer connection, lighting, ventilation, security, wash down provisions etc)	N/A